staller Name:	OSSF Installer #:	
1st Inspection Date:	2nd Inspection Date:	3rd Inspection Date:
Inspector Name:	Inspector Name:	Inspector Name:

Perm	it#:		Address:				
No.	Description	Answer	Citations	Notes	1st Insp.	2nd Insp.	3rd Insp.
1	SITE AND SOIL CONDITIONS & SETBACK DISTANCES Site and Soil Conditions Consistent with Submitted Planning Materials		285.31(a) 285.30(b)(1)(A)(iv) 285.30(b)(1)(A)(v) 285.30(b)(1)(A)(iii) 285.30(b)(1)(A)(ii) 285.30(b)(1)(A)(i)				
2	SITE AND SOIL CONDITIONS & SETBACK DISTANCES Setback Distances Meet Minimum Standards		285.91(10) 285.30(b)(4) 285.31(d)				
3	SEWER PIPE Proper Type Pipe from Structure to Disposal System (Cast Iron, Ductile Iron, Sch. 40, SDR 26)		285.32(a)(1)				
4	SEWER PIPE Slope from the Sewer to the Tank at least 1/8 Inch Per Foot		285.32(a)(3)				
5	SEWER PIPE Two Way Sanitary - Type Cleanout Properly Installed (Add. C/O Every 100' &/or 90 degree bends)		285.32(a)(5)				
6	PRETREATMENT Installed (if required) TCEQ Approved List PRETREATMENT Septic Tank(s) Meet Minimum Requirements		285.32(b)(1)(G) 285.32(b)(1)(E)(iii) 285.32(b)(1)(E)(iv) 285.32(b)(1)(F) 285.32(b)(1)(B) 285.32(b)(1)(C)(i) 285.32(b)(1)(C)(ii) 285.32(b)(1)(D) 285.32(b)(1)(E) 285.32(b)(1)(E) 285.32(b)(1)(E) 285.32(b)(1)(E)(ii)(II) 285.32(b)(1)(E)(ii)(II) 285.32(b)(1)(E)(ii)(II)				
7	PRETREATMENT Grease Interceptors if required for commercial		285.34(d)				


**Inspector Notes:** 

N-	December 41	A may	Citotiana	Net	1 at 1	2 m d 1	7 mal 1
No.	Description SEPTIC TANK Tank(s) Clearly	Answer	Citations	Notes	1st Insp.	2nd Insp.	3rd Insp.
8	Marked SEPTIC TANK IsingleTank, 2Compartments Provided withBaffle SEPTIC TANK Inlet Flowline Greater than3" and "T" Provided on Inlet and OutletSEPTIC TANK Septic Tank(s) MeetMinimum Requirements		285.32(b)(1) (E)285.91(2)285.32(b)(1) (F)285.32(b)(1)(E) (iii)285.32(b)(1)(E)(ii) (I)285.32(b)(1)(E) (i)285.32(b)(1)(E) (i)285.32(b)(1)(C) (ii)285.32(b)(1)(C) (ii)285.32(b)(1)(C) (ii)285.32(b)(1) (B)285.32(b)(1) (A)285.32(b)(1)(E)(iv)				
1	ALL TANKS Installed on 4" Sand Cushion/ Proper Backfill Used		285.32(b)(1)(F) 285.32(b)(1)(G) 285.34(b)				
	SEPTIC TANK Inspection / Clean Out Port & Risers Provided on Tanks Buried Greater than 12" Sealed and Capped		285.38(d)				
	SEPTIC TANK Secondary restraint system providedSEPTIC TANK Riser permanently fastened to lid or cast into tank SEPTIC TANK Riser cap protected against unauthorized intrusions		285.38(d) 285.38(e)				
	SEPTIC TANK Tank Volume Installed						
12							
	PUMP TANK Volume Installed						
1	AEROBIC TREATMENT UNIT Size Installed						
14							
	AEROBIC TREATMENT UNIT Manufacturer AEROBIC TREATMENT UNIT Model Number						
15	DISPOSAL SYSTEM Absorptive		285.33(a)(4) 285.33(a)(1) 285.33(a)(2) 285.33(a)(3)				
17	DISPOSAL SYSTEM Leaching Chamber		285.33(a)(1) 285.33(a)(3) 285.33(a)(4) 285.33(a)(2)				
18	DISPOSAL SYSTEM Evapo- transpirative		285.33(a)(3) 285.33(a)(4) 285.33(a)(1) 285.33(a)(2)				
18			203.33(a)(2)				

No.	Description	Answer	Citations	Notes	1st Insp.	2nd Insp.	3rd Insp.
	DISPOSAL SYSTEM Drip Irrigation	Allowei	Citations	Notes	13t 1113p.	Ziiu iiisp.	Sid ilisp.
	DIST COAL STOTENT DITP ITTIGATION		20E 22(a)(2)(A) (E)				
			285.33(c)(3)(A)-(F)				
19	DISPOSAL SYSTEM Soil						
20	Substitution		285.33(d)(4)				
20	DISPOSAL SYSTEM Pumped						
	Effluent		285.33(a)(4) 285.33(a)(3)				
			285.33(a)(1)				
21			285.33(a)(2)				
	DISPOSAL SYSTEM Gravelless Pipe						
	·		285.33(a)(3)				
			285.33(a)(2)				
			285.33(a)(4)				
22			285.33(a)(1)				
22	DISPOSAL SYSTEM Mound		205 22/ 1/51				
			285.33(a)(3) 285.33(a)(1)				
			285.33(a)(1) 285.33(a)(2)				
23			285.33(a)(4)				
23	DISPOSAL SYSTEM Other						
	(describe) (Approved Design)		285.33(d)(6) 285.33(c)(4)				
24			263.33(C)(4)				
	DRAINFIELD Absorptive Drainline 3" PVC						
	or 4" PVC						
25							
	DRAINFIELD Area Installed						
26	DRAINFIELD Level to within 1 inch						
	per 25 feet and within 3 inches						
	over entire excavation		285.33(b)(1)(A)(v)				
27							
	DRAINFIELD Excavation Width DRAINFIELD Excavation Depth						
	DRAINFIELD Excavation Separation						
	DRAINFIELD Depth of Porous Media						
	DRAINFIELD Type of Porous Media						
28							
	DRAINFIELD Pipe and Gravel - Geotextile Fabric in Place		285.33(b)(1)(E)				
29			(-/\-/\-/				
	DRAINFIELD Leaching Chambers DRAINFIELD Chambers - Open End						
	Plates w/Splash Plate, Inspection						
	Port & Closed End Plates in Place		285.33(c)(2)				
	(per manufacturers spec.)						
30							
	LOW PRESSURE DISPOSAL						
	SYSTEM Adequate Trench Length						
	& Width, and Adequate Separation Distance between		285.33(d)(1)(C)(i)				
	Trenches						
31							

No.	Description	Answer	Citations	Notes	1st Insp.	2nd Insp.	3rd Insp.
	EFFLUENT DISPOSAL SYSTEM Utilized Only by Single Family Dwelling EFFLUENT DISPOSAL SYSTEM Topographic Slopes < 2.0% EFFLUENT DISPOSAL SYSTEM Adequate Length of Drain Field ( 1000 Linear ft. for 2 bedrooms or Less & an additional 400 ft. for each additional bedroom ) EFFLUENT DISPOSAL SYSTEM Lateral Depth of 18 inches to 3 ft. & Vertical Separation of 1ft on bottom and 2 ft. to restrictive horizon and ground water respectfully EFFLUENT DISPOSAL SYSTEM Lateral Drain Pipe (1.25 - 1.5" dia.) & Pipe Holes ( 3/16 - 1/4" dia. Hole Size ) 5 ft. Apart		285.33(b)(3)(A) 285.33(b)(3)(A) 285.33(b)(3) (B)285.91(13) 285.33(b)(3)(D) 285.33(b)(3)(F)				
	AEROBIC TREATMENT UNIT IS Aerobic Unit Installed According to Approved Guidelines.		285.32(c)(1)				
34	AEROBIC TREATMENT UNIT Inspection/Clean Out Port & Risers Provided AEROBIC TREATMENT UNIT Secondary restraint system provided AEROBIC TREATMENT UNIT Riser permanently fastened to lid or cast into tank AEROBIC TREATMENT UNIT Riser cap protected against unauthorized intrusions						
35	AEROBIC TREATMENT UNIT Chlorinator Properly Installed with Chlorine Tablets in Place.						
36	PUMP TANK Is the Pump Tank an approved concrete tank or other acceptable materials & construction PUMP TANK Sampling Port Provided in the Treated Effluent Line PUMP TANK Check Valve and/or Anti- Siphon Device Present When Required PUMP TANK Audible and Visual High Water Alarm Installed on Separate Circuit From Pump						
	PUMP TANK Inspection/Clean Out Port & Risers Provided PUMP TANK Secondary restraint system provided PUMP TANK Riser permanently fastened to lid or cast into tank PUMP TANK Riser cap protected against unauthorized intrusions						
38	PUMP TANK Secondary restraint system provided						
	PUMP TANK Electrical Connections in Approved Junction Boxes / Wiring Buried						

				-			
No.	Description	Answer	Citations	Notes	1st Insp.	2nd Insp.	3rd Insp.
	APPLICATION AREA Distribution Pipe, Fitting, Sprinkler Heads & Valve Covers Color Coded Purple?		285.33(d)(2)(G)(iii)(II) 285.33(d)(2)(G)(iii)(III) 285.33(d)(2)(G)(v) 285.33(d)(2)(G)(iii) 285.33(d)(2)(G)(iv) 285.33(d)(2)(G)(i) 285.33(d)(2)(G)(iii) 285.33(d)(2)(G)(iii)(I)				
	APPLICATION AREA Low Angle Nozzles Used / Pressure is as required APPLICATION AREA Acceptable Area, nothing within 10 ft of sprinkler heads? APPLICATION AREA The Landscape Plan is as Designed		285.33(d)(2)(G) (i)285.33(d)(2) (A)285.33(d)(2)(F)				
	APPLICATION AREA Area Installed						
	PUMP TANK Meets Minimum Reserve Capacity Requirements						
	PUMP TANK Material Type & Manufacturer						
	PUMP TANK Type/Size of Pump Installed						

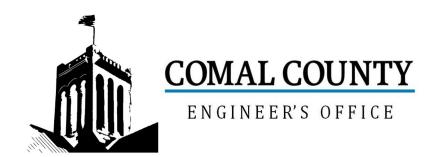

# Permit of Authorization to Construct an On-Site Sewage Facility Permit Valid For One Year From Date Issued

Permit Number: 117642

Issued This Date: 11/06/2024

This permit is hereby given to: Kyle & Andrea Herring

To start construction of a private, on-site sewage facility located at:

2571 COMAL SPGS

CANYON LAKE, TX 78133

Subdivision: Mountain Springs Ranch

Unit: 3

Lot: 447

Block: 0

Acreage: 0.0000


#### APPROVED MINIMUM SIZES AS PER ATTACHED DESIGN

Type of System: Aerobic

Surface Irrigation

This permit gives permission for the construction of the above referenced on-site facility to commence. Installation must be completed by an installer holding a valid registration card from the Texas Commission on Environmental Quality (TCEQ). Installation and inspection must comply with current TCEQ and Comal County requirements.

Call (830) 608-2090 to schedule inspections.

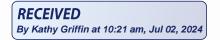



## **OSSF DEVELOPMENT APPLICATION CHECKLIST**

Staff will complete shaded items

Initials

117642

Permit Number

Instructions: Place a check mark next to all items that apply. For items that do not apply, place "N/A". This OSSF Development Application. Checklist <u>must</u> accompany the completed application.
OSSF Permit
Completed Application for Permit for Authorization to Construct an On-Site Sewage Facility and License to Operate
Site/Soil Evaluation Completed by a Certified Site Evaluator or a Professional Engineer
Planning Materials of the OSSF as Required by the TCEQ Rules for OSSF Chapter 285. Planning Materials shall consist of a scaled design and all system specifications.
Required Permit Fee - See Attached Fee Schedule
Copy of Recorded Deed
Surface Application/Aerobic Treatment System
Recorded Certification of OSSF Requiring Maintenance/Affidavit to the Public
Signed Maintenance Contract with Effective Date as Issuance of License to Operate
Existing permit # 109421
I affirm that I have provided all information required for my OSSF Development Application and that this application constitutes a completed OSSF Development Application.
Signature of Applicant  Date
COMPLETE APPLICATION  Check No Receipt No   INCOMPLETE APPLICATION   (Missing Items Circled, Application Refeused)
Revised: September 2019

Date Received

**RECEIVED**By Kathy Griffin at 10:21 am, Jul 02, 2024

## \* \* \* COMAL COUNTY OFFICE OF ENVIRONMENTAL HEALTH \* \* \*

# APPLICATION FOR PERMIT FOR AUTHORIZATION TO CONSTRUCT AN ON-SITE SEWAGE FACILITY AND LICENSE TO OPERATE

ые <u>5/20/2</u> 0	024		Permit #	117642
wner Name	Kyle & Andrea Herring	Agent Name	South Texas Waste	ewater Treatment
Aailing Address	2571 Comal Springs	Agent Address	PO Box 1284	
City, State, Zip	Canyon Lake, TX 78133	City, State, Zip	Boerne, TX 78006	
hone #	(281)979-4819	Phone #	(830) 249-8098	
Email	diandra@stwastewater.com	_ Email	diandra@stwastew	rater.com
All corres	spondence should be sent to:   Owner	Agent  Both	Method:	Mail 🔀 Email
Subdivision Nan	ne Mountain Springs Ranch	Unit <u>3</u>	Lot 447	Block
\creage/Legal _				
Street Name/Ad	dress 2571 Comal Springs		yon Lake	Zip <u>78133</u>
ype of Develo	pment:			
Single Far	nily Residential			
Type of Cor	nstruction (House, Mobile, RV, Etc.) House			
Number of E	Bedrooms 4 bdrm			
Indicate Sq	Ft of Living Area 3,947			
☐ Non-Singl	e Family Residential			
(Planning mate	erials must show adequate land area for doubling t	he required land needed	I for treatment units an	nd disposal area)
Type of Fac	ility			
Offices, Fac	tories, Churches, Schools, Parks, Etc Indica	—— ate Number Of Occup	ants	
	s, Lounges, Theaters - Indicate Number of Sea			
Hotel, Motel	, Hospital, Nursing Home - Indicate Number o	of Beds		
Travel Traile	er/RV Parks - Indicate Number of Spaces			
Miscellaneo				
Estimated Cos	st of Construction: \$ 234,000 (Pool) (Str			
Is any portion	of the proposed OSSF located in the United S	States Army Corps of I	Engineers (USACE)	flowage easement?
☐ Yes ☐	No (If yes, owner must provide approval from USACE	E for proposed OSSF impro	vements within the USA	CE flowage easement)
ource of Water	□ Private Well			
re Water Savin	g Devices Being Utilized Within the Residenc	e? 🛛 Yes 🗌 No		
The completed a facts. I certify the property. Authorization is h	polication, I certify that: pplication and all additional information submitted at I am the property owner or I possess the approp	riate land rights necessa	ary to make the permitt	ted improvements on said
I understand that by the Comal Co	on and inspection of private sewage facilities  a permit of authorization to construct will not be is bunty Flood Damage Prevention Order.  Insent to the online posting/public release of my e-needs.			
	Shitto	5/20/2024		
Signature of	wner V	Date		Page 1 of 2

#### \* \* \* COMAL COUNTY OFFICE OF ENVIRO

APPLICATION FOR PERMIT FOR AUTHORIZA

# **RECEIVED**

By Brandon Olvera at 9:23 am, Nov 06, 2024

ON-SITE SEWAGE FACILITY AND LICENSE TO OPERATE

Planning Materials & Site Evaluation as Required Completed By South Texas Wastewater Treatment
System Description Aerobic/ Surface Spray
Size of Septic System Required Based on Planning Materials & Soil Evaluation
Tank Size(s) (Gallons) 750/750 Absorption/Application Area (Sq Ft)
Gallons Per Day (As Per TCEQ Table III)
(Sites generating more than 5000 gallons per day are required to obtain a permit through TCEQ.)
Is the property located over the Edwards Recharge Zone?   Yes   No
(If yes, the planning materials must be completed by a Registered Sanitarian (R.S.) or Professional Engineer (P.E.))
Is there an existing TCEQ approved WPAP for the property?   Yes   No
(If yes, the R.S. or P.E. shall certify that the OSSF design complies with all provisions of the existing WPAP.)
If there is no existing WPAP, does the proposed development activity require a TCEQ approved WPAP?   Yes   No
(If yes, the R.S. or P.E. shall certify that the OSSF design will comply with all provisions of the proposed WPAP. A Permit to Construct will not be issued for the proposed OSSF until the proposed WPAP has been approved by the appropriate regional office.)
Is the property located over the Edwards Contributing Zone? ⊠ Yes □ No
Is there an existing TCEQ approval CZP for the property?   Yes   No
(If yes, the P.E. or R.S. shall certify that the OSSF design complies with all provisions of the existing CZP.)
If there is no existing CZP, does the proposed development activity require a TCEQ approved CZP?   Yes  No
(If yes, the R.S. or P.E. shall certify that the OSSF design will comply with all provisions of the proposed CZP. A Permit to Construct will not be issued for the proposed OSSF until the CZP has been approved by the appropriate regional office.)
Is this property within an incorporated city?   Yes   No
If yes, indicate the city:

By signing this application, I certify that:

- The information provided above is true and correct to the best of my knowledge.

- I affirmatively consent to the online posting/public release of my e-mail address associated with this permit application, as applicable.

Signature of Designer

ate

Page 2 of 2

# RECEIVED

By Brandon Olvera at 9:35 am, Nov 06, 2024

01906024585 07/17/2019 02:06:18 PM 1/1

AFFIDAVIT TO THE PUBLIC

THE COUNTY OF COMAL STATE OF TEXAS

#### CERTIFICATION OF OSSF REQUIRING MAINTENANCE

According to Texas Commission on Environmental Quality Rules for On-Site Sewage Facilities, this document is filed in the Deed Records of Comal County, Texas. The Texas Health and Safety Code, Chapter 366 authorizes the Texas Commission on Environmental Quality (TCEQ) to regulate on-site sewage facilities (OSSFs). Additionally, the Texas Water Code (TVVC), 5.012 and 5.013, gives the TCEQ primary responsibility for implementing the laws of the State of Texas relating to water and adopting rules necessary to carry out its powers and duties under the TVVC. The TCEQ, under the authority of the TWC and the Texas Health and Safety Code, requires owners to provide notice to the public that certain types of OSSFs are located on specific pieces of property. To achieve this notice, the TCEQ requires a deed recording. Additionally, the owner must provide proof of the recording to the OSSF permitting authority. This deed certification is not a representation or warranty by the TCEQ of the suitability of this OSSF, nor does it constitute any guarantee by the TCEQ that the appropriate OSSF was installed.

guarantee by the folia the appropriate oool was installed.	
	II
An OSSF requiring a maintenance contract, according to 30 Texas Administrative Code 2 the property described as (insert legal description):	85.91(12) will be installed on
Lot 447 Block Subdivision Mountain Springs Ranch	Unit 3
If not in Subdivision: Acres	Survey
The property is owned by (insert owner's full name): Kyle C Herring & Andrea J Herring	
This OSSF must be covered by a continuous maintenance contract for the first two years. After the owner of an aerobic treatment system for a single family residence shall either obtain a mainten maintain the system personally.	e initial two-year service policy, nance contract within 30 days or
Upon sale or transfer of the above-described property, the permit for the OSSF shall be transferred to of the planning materials for the OSSF can be obtained from the Contal County Engineer's Office.	the buyer or new owner. A copy
Kyle C Herring Owner Name Owner Si	ignature
Andrea J HerringOwner NameOwner Sig	gnature
This instrument was acknowledged before me on:	9
Johnny Trisiun Notary's Printed Name	
Notary Public State	
Notary Public, State of Texas  Filed and Recorded Official Public Records	
Commission Expires: Sylvariant Bobbie Koepp, County Cl	erk

JOHNNY TRIGIANO Notary Public, State of Texas Comm. Expires 03-18-2023 Notary ID 131935218

#### South Texas Wastewater Treatment PO Box 1284 Boerne, TX 78006

Date: 6/24/2019

Phone: (830) 249-8098

bruce@stwastewater.com

To: Kyle C & Andrea J Herring 431 Upland Ct Canyon Lake, TX 78133

Contract Period

Start Date: End Date:

Phone:

Subdivision: Mtn Springs Ranch 3

Site: 2571 Comal Springs, Canyon Lake, TX 78133

County: Comal

Installer: Ronald R Graham

Agency: Comal County Environmental

Mfg/Brand: Jet, Inc. / J-750- 2 yr

South Texas Wastewater Treatment

3 visits per year - one every 4 months

360 gallons per day

Map Key: 386 C2

General: This Work for Hire Agreement ( hereinafter referred to as "Agreement") is entered into by and between South Texas Wastewater Treatment and the above referrenced name (referred to as Customer). By this agreement, South Texas Wastewater Treatment and its' employees (hereinafter referred to as "Contractor") agree to render services at the site address stated above, as described herein, and the Customer agrees to fulfill his/her/their responsibilities, as described herein. Effective Dates: This agreement commences and ends as noted above. The date of commencement will be the date the "License to Operate" was issued by the permitting authority. The agreement may or may not commence at the same time as any warranty period of installed equipment, but in no case shall it extend the specified warranty as stated in our PROPOSAL AND CONTRACT FOR SERVICES.

Renewal: This Agreement shall automatically renew for an additional period of two (2) years at the same terms and conditions unless either party gives notice of termination a minimum of thirty (30) days prior to end of first agreement period. See Section IV.

- Termination of Agreement: This Agreement may be terminated by either party with thirty (30) days written notice for any reason, including for example, substantial failure to perform in accordance with its terms, without fault or liability of the terminating party. NO REFUNDS. If this Agreement is so terminated, Contractor will be paid at the rate of \$85.00 per hour for any work performed and for which compensation has not been received. Either party terminating this agreement for any reason, including non-renewal, shall notify in writing the appropriate regulatory agency a minimum of thirty (30) days prior to the date of such Services: Contractor will:
  - A. Inspect and perform routine upkeep on the On-Site Sewage Facility (hereinafter referred to as OSSF) as recommended by the treatment system manufacturer, and required by state and/or local regulations approximately every four months.

B. Provide a written record of visits to the site by means of an inspection tag attached to or contained in or near the control panel.

C. Repair or replace: if repairs or replacement of parts is necessary during a routine service visit, the repair or replacement of parts will be made at that time, if the charges for parts do not exceed \$100.00. If the charges for parts exceed \$100.00, the homeowner will be contacted for approval at the number(s) provided by the homeowner below. If the homeowner cannot be reached for approval while the technician is at the property, the repairs will not be made if they exceed \$100.00. If the technician receives approval after he leaves the property, a service call charge of \$85.00 to return to the property will be added to the final bill. If warranted items are required to be replaced within 30days of installation, labor will not be charged; after 30

D. Provide sample collection and laboratory testing of TSS and BOD on a yearly basis as required by permit. An additional charge will be incurred by the Customer for this service. (Only required for other than single family residence.).

Forward copies of this Agreement and all reports to the regulatory agency and the customer within 14 days.

- Visit site in response to Customer's request for unscheduled service within forty-eight (48) hours of the date of notification of said request. Unless otherwise covered by warranty, costs for such unscheduled responses will be billed to Customer.
- VI. Disinfection: \_\_\_\_Not Required. \_X Required. The responsibility to maintain the disinfection device (s) and provide any necessary chemicals is that of the Customer: If the Customer pays for it (See Attached Invoice), Contractor will add 12 tablets of chlorine at routine services (See Section V Sub-section A)

VII. Electronic Monitoring \_\_\_ is \_X\_ is not included in this Agreement.

VIII. Performance of Agreement: Commencement of performance by Contractor under this agreement is contingent on the following conditions:

1. Contractor's receipt of a fully executed original copy or email of this agreement and all documentation requested

2. Contractor providing the equipment and installation for this OSSF.

- 3. Contractor's receipt of payment in full for the equipment and installation.
- 4. Contractor's receipt of payment of the wastewater monitoring fee in accordance with the terms as described in section XIV of this Agreement.
- B. If this is not an initial agreement (existing system):
  - Contractor's receipt of a fully executed original copy of this agreement and all documentation requested by Contractor.
- 2. Contractor's receipt of payment of the wastewater monitoring fee in accordance with the terms as described in Section XIV of this agreement C. If the above conditions are not met, Contractor is not obligated to perform any portion of this agreement.

IX. Customer's Responsibilities: The Customer is responsible for each and all of the following

A. DO NOT ALLOW ALTERATION TO ANY PART OF THE SYSTEM OR SPRINKLER HEAD LOCATIONS. ALTERATIONS WOULD PUT

#### SOUTH TEXAS WASTEWATER

Authorized JET Distributor - Home and Commercial - E P O Box 1284 Boerne, Texas 78006 \* 830-249-8098 or

# RECEIVED

By Brandon Olvera at 9:35 am, Nov 06, 2024

## SITE EVALUATION INFORMATION SHEET

Kyle C & Andrea J Herring 431 Upland Ct Canyon Lake TX 78133 c/o RIR Custom Homes

SITE: 2571 Comal Springs

Lot 447

Mountain Springs Ranch 3 Comal County, Texas

Date Site Evaluation Performed: 21 June 2019 Within 100 year Flood zone No, FIR Map 48091C 0230F Edwards Recharge Zone: No , USGS map Index map Profile Holes: No test holes dug due to significant surface rock. Honeycomb, slab, fractured limestone, etc. Soil Texture Analysis: Class suitable NO Soil Structure Analysis: \_\_\_\_\_ suitable X unsuitable for conventional septic Structureless \_\_\_\_\_ Weak\_\_\_\_\_ Moderate \_\_\_\_ Strong \_\_\_\_ Blocky\_\_\_ Platy\_\_\_\_\_(unsuitable) Massive\_\_\_\_(unsuitable) Restrictive Horizon: None found: \_\_\_\_\_ Depth: surface Rock or Fractured Rock: x Clay 40% or more \_\_\_\_ Ground Water N/A Brief Description: No identified recharge features within 150' of proposed system location. No actual drainage features on lot. This site evaluated by: South Texas Wastewater Treatment Ronald R. Graham, Site Evaluator Registration Number 19772, State of Texas PO Box 1284, Boerne, Texas Ronald R. Graham, SE



PO Box 1284 Boerne, TX 78006 830-249-8098

I, Ronald R. Graham have reviewed the CZP# 2072.01 for this location and certify that this design meets all of the requirements of the Texas Commission of Environmental Quality OSSF regulations, all provisions of the existing CZP and the orders of Comal County.

Ronald R. Graham, RS 3741

## SOUTH TEXAS WASTE WATER TREATMENT, LLC.

Authorized JET Distributor - Home and Commercial - Engineering Services P O Box 1284 Boerne, Texas 78006 \* 830-249-8098 or 1-800-86-WASTE; www.stwastewater.com

#### JET HOME WASTEWATER TREATMENT SYSTEM DESIGN SPRINKLER SYSTEM

Kyle & Andrea Herring (281) 979-4819 kyleh@strongclaims.com

SITE: 2571 Comal Springs Mountain Springs Ranch 3 Lot 447

Comal County, Texas

This design includes an attached drawing No. 7134R1 dated 10 JUN 2024 Design Specifications:

Estimated average daily wastewater flow: 4 bedroom 3,947sf home (360GPD)

With effluent treatment of 600 GPD

Pump tank/chlorine contact chamber capacity: 750 gallons

Design application rate: 0.064 gal./sq.ft./day Dosing cycle quantity: 100-110 gallons Number of dosing cycles per day: three (3) Type of float switch: mercury float switch

Design pressure head: 25-40 psi at sprinkler head

Total length of supply pipe: 180 feet

Dosing pump capacity: Little Giant WE20G05P4-22-20.0 GPM 25-40 psi

NSF Certified tablet Chlorinator: installed at inlet of pump tank

Safety lid installed on clarifier

Maximum slope of the field: <15 percent Means of preventing syphoning: hose bib Type of forced main required: 1" SCH 40

Diameter of supply pipe: 1 inch

Pressure adjusting valves to be installed: hose bib

Offsets: property lines, wells, easements, water lines, structures, swimming pools, ponds, etc shall be strictly adhered to as required by latest Texas Natural Resources Conservation Commission construction standards.

Pump controls must have NEMA (National Manufacturing Association) approval. A PVC union shall be placed above the pump to allow for easy pump removal.

#### Calculation of field Size

Four bedroom (3,947 sq ft) -allow 360 GPD effluent flow Assume an application rate of 15.6 square feet per gallon per day.  $360 \div 0.064 = 5,625 \text{ sf}$ 

We are relocating existing spray heads and adding additional heads to accommodate a new pool. 5 sprinkler heads, 4 with a 35' radius, 3 spraying a half circle, and one spraying a ½ circle. One spray head with a radius of 30' spraying a half circle. The area covered as measured by autocad is

A = 6,859 sf

#### Pipe and fittings

All pipes and fittings in this system shall be schedule 40 PVC. All joints shall be sealed with an approved solvent-type PVC cement. The forced main shall be 1 inch in diameter. A Little Giant WE20G05P4-22 or equivalent high head submersible pump capable of providing at least 6 GPM and providing a 25-40 psi head shall be utilized for pumping effluent.

#### Site Preparation

The area selected for irrigation shall be cleared of cedar and brush. Some preparation is required. Sprayed area shall be provided with grass or other suitable ground cover.

#### Provisions for Emergencies

A warning system shall be added to the pump tank on a separate circuit from the pump circuit to provide warning of a failure of the system. This aerobic system has a 24 month service agreement which includes emergency service.

#### Flood Prone Areas

The subject lot is <u>not</u> in a flood prone area according to National Flood Insurance Program FIR Map community-panel Number <u>48091C0230F</u>.

#### Tank Sizes

The system shall have a JET Model J-750 extended aeration plant with external NSF Certified tablet chlorinator. The pump tank shall have a capacity of 750 gal. This tank will not need tees on inlet. Safety lid installed on clarifier.

This system designed by:

South Texas Wastewater Treatment Ronald R. Graham, Registered Sanitarian Registration Number 3741, State of Texas PO Box 1284, Boerne, Texas

Ronald R. Graham, RS


Date 28. 2029

Attachments:

Drawing No. 7134R1 dated 10 JUN 2024

## RECEIVED

By Brandon Olvera at 9:42 am, Nov 06, 2024

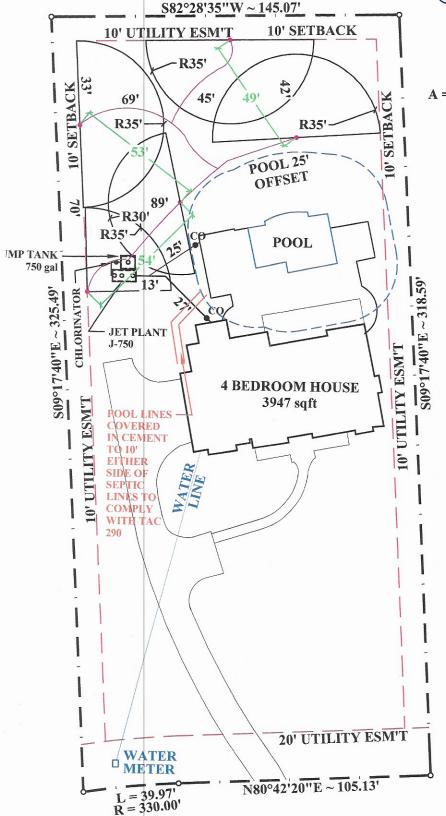

A = 6,859 sqft



NOTES:

- 1. THIS DESIGN MEETS ALL OF THE REQUIREMENTS OF THE TEXAS COMMISSION ON ENVIRONMENTAL QUALITY OSSF REGULATIONS AND THE ORDERS OF COMAL COUNTY AND WILL NOT CAUSE A NUISANCE OR HEALTH HAZARD
- 2. ALL SPRINKLERS ARE HUNTER PGP-ARV-LA OR K-RAIN PROPLUS
- 3. ANY CROSSING OF WATER LINE & SPRAY LINE WILL BE SLEEVED 10 ft ON EACH SIDE OF WATER LINE
- 4. NO PHYSICAL DRAINAGE FEATURE ON PROPERTY WHICH WOULD REQUIRE SPECIAL PROTECTIVE MEASURES
- 5. NO TEST HOLES DUG DUE TO EXTENSIVE SURFACE ROCK

# **COMAL SPRINGS**


SOUTH TEXAS WASTE WATER
TREATMENT
P.O. BOX 1284
BOERNE, TX 78006
830-249-8098
BY RONALD R. GRAHAM R.S. 3741


2571 Comal Springs
Lot 447
Mountain Springs Ranch 3
COMAL COUNTY, TEXAS


Rev	Date	By	lan	
0	JUN 27 2019	RCC	DRAWING NO.	7134R1
1	JUN 10 2024	RCC		~
			DATE	JUN 10 2024


40'


80'

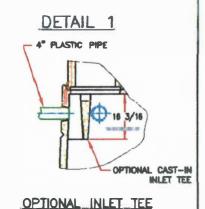

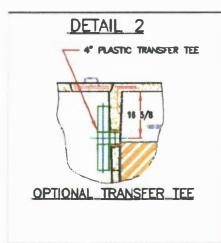

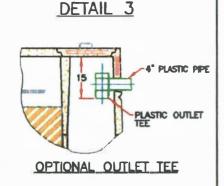

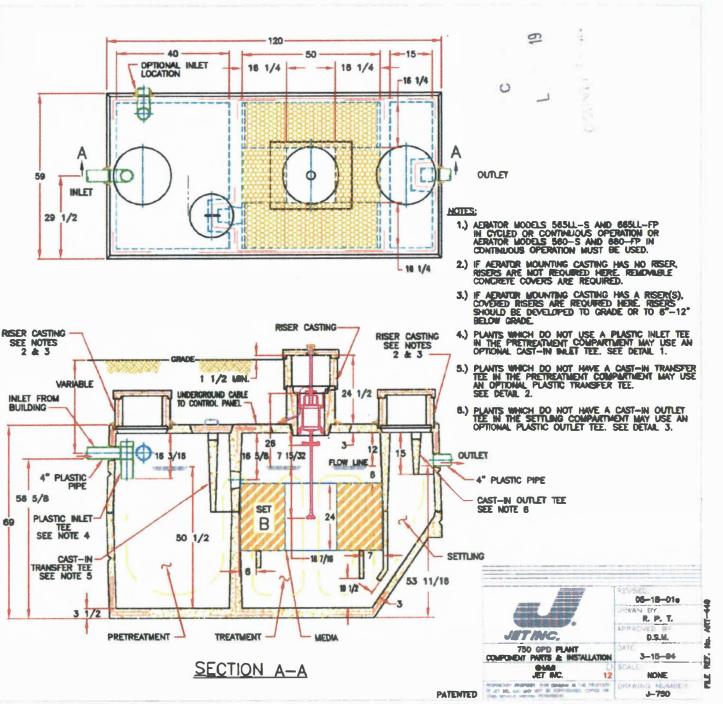

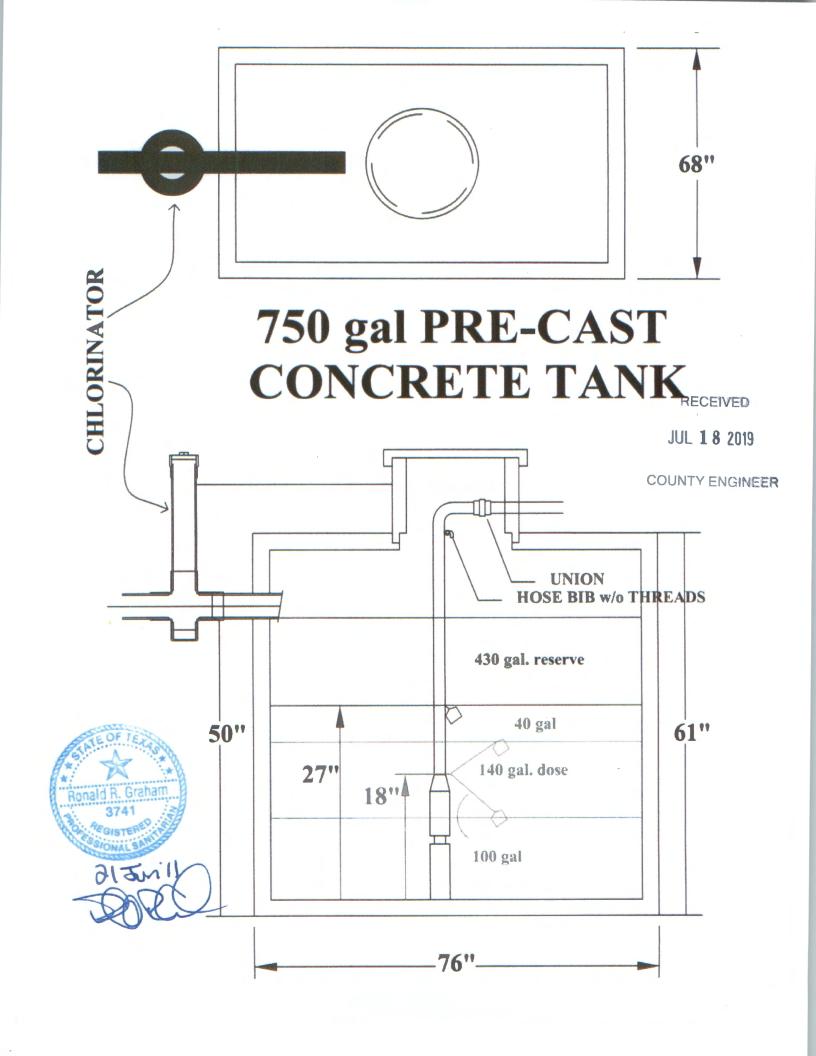

#### \* \* \* COMAL COUNTY OFFICE OF ENVIRONMENTAL HEALTH \* \* \*

# APPLICATION FOR PERMIT FOR AUTHORIZATION TO CONSTRUCT AN ON-SITE SEWAGE FACILITY AND LICENSE TO OPERATE

By signing this application, I certify that:


- The information provided above is true and correct to the best of my knowledge.

- I affirmatively consent to the online posting/public release of my e-mail address associated with this permit application, as applicable.

Signature of Designer

Q 6-28-24

Page 2 of 2

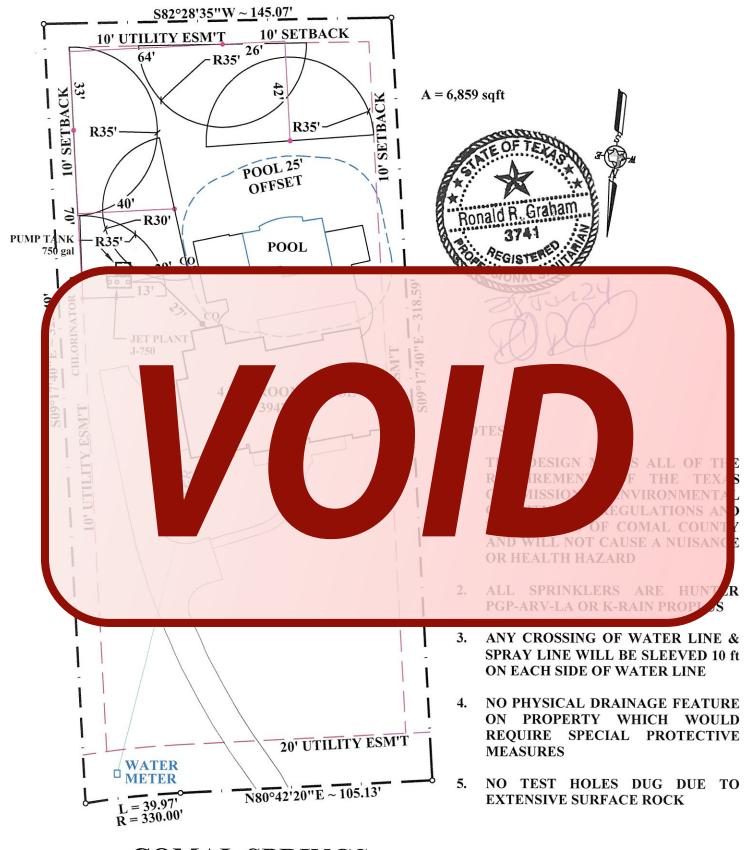

# **COMAL SPRINGS**

				RECORD .	<b>企工500余</b>	
SOUTH TEXAS WASTEWATER	2571 Comal Springs	Rev	Date	By	DRAWING NO.	7134R1
TREATMENT	1 0	0	JUN 27 2019	RCC	DRAWING NO.	/134K1
P.O. BOX 1284	Lot 447	1	JUN 10 2024	RCC	DATE	JUN 10 2024
BOERNE, TX 78006 830-249-8098	Mountain Springs Ranch 3				DATE	JUN 10 2024
BY RONALD R. GRAHAM R.S. 3741	COMAL COUNTY, TEXAS				SCALE	1'' = 40'

40'

80'

## RECEIVED

By Brandon Olvera at 9:36 am, Oct 21, 2024

40'

DRAWING NO.

DATE


SCALE

80'


7134R1

JUN 10 2024

1'' = 40'

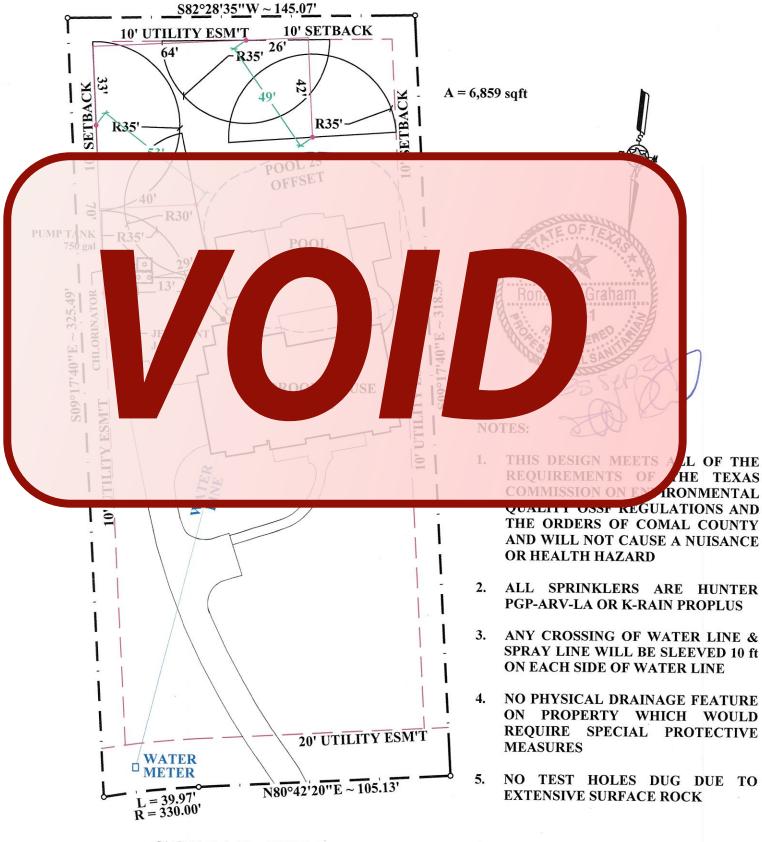

## **COMAL SPRINGS**

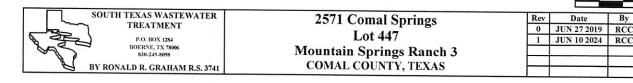

July 29, 2024

Permit: 117642




\_\_\_\_\_

RE: 2571 Comal Springs Mountain Springs Ranch 3 Lot 447

Dear Property Owner & Agent,

Thank you for your submission. We have reviewed the planning materials for the referenced permit application, and unfortunately, they are insufficient. To proceed with processing this permit, we require the following:

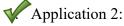

- a. What are the square feet of absorption area.
- b. What are the purposed gallons per day.
- V. Submit the site and soil evaluation.
- The system description does not match the site plan.
- 4. Site Plan:
  - Show the distance between the overlapping spray heads.
  - Show the location of the test holes.
  - Do any of the pool waterlines come within 10 ft of the OSSF components?
- 5. Revise accordingly and resubmit.

If you have any questions, you can email me or call the office.

Thank You,

Brandon Olvera Designated Representative OS0034792

Comal County | www.cceo.org | f: 830-608-2078 | e: olverb@co.comal.tx.us |

# **CCEO COPY**



# **COMAL COUNTY**

#### ENGINEER'S OFFICE

#### License to Operate On-Site Sewage Treatment and Disposal Facility

Issued This Date:

01/10/2020

Permit Number:

109421

Location Description:

2571 COMAL SPGS

CANYON LAKE, TX 78133

Subdivision:

Mountain Springs Ranch

Unit:

3

t:

Lot:

447

Block:

Acreage:

Type of System:

Aerobic

Surface Irrigation

Issued to:

Kyle C. & Andrea J. Herring

This license is authorization for the owner to operate and maintain a private facility at the location described in accordance to the rules and regulations for on-site sewerage facilities of Comal County, Texas, and the Texas Commission on Environmental Quality.

The license grants permission to operate the facility. It does not guarantee successful operation. It is the responsibility of the owner to maintain and operate the facility in a satisfactory manner.

Alterations to this permit including, but not limited to:

- Increase in the square feet of living area
- Increase in the number of bedrooms
- A change of use (i.e. residential to commercial)
- Relocation of system components (including the relocation of spray heads)
- Installation of landscaping
- Adding new structures to the system

may require a new permit. It is the responsibility of the owner to apply for a new permit, if applicable.

Inspection and licensing of a facility indicates only that the facility meets certain minimum requirements. It does not impede any governmental entity in taking the proper steps to prevent or control pollution, to abate nuisance, or to protect the public health.

This license to operate is valid for an indefinite period. The holder may transfer it to a succeeding owner, provided the facility has not been remodeled and is functioning properly.

Licensing Authority


Comal County Environmental Health

OS0034792

NVIRONMENTAL HEALTH INSPECTOR

ENVIRONMENTAL HEALTH COORDINATOR

OS 0025599

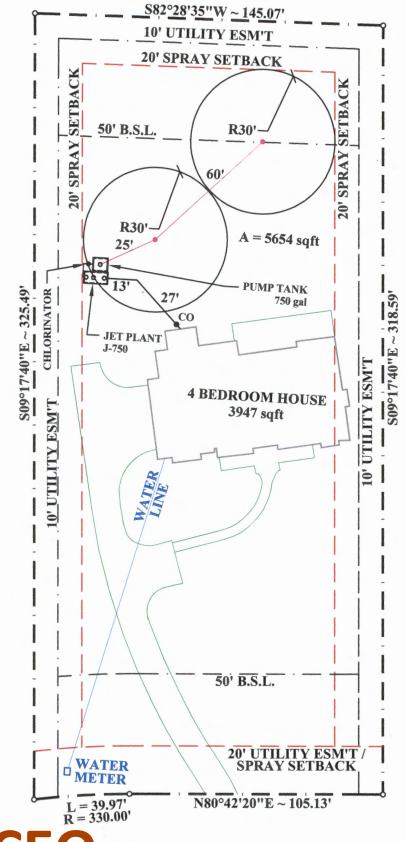

CCE@omal springs COPY

SYSTEM DESIGN

**FOR** 

2571 Comal Springs Lot 447 Mountain Springs Ranch 3

COMAL COUNTY, TEXAS

BY

RONALD R. GRAHAM R.S. 3741

SOUTH TEXAS WASTEWATER TREATMENT P.O. BOX 1284 **BOERNE, TX 78006** 830-249-8098

- THIS DESIGN MEETS ALL OF THE REQUIREMENTS OF THE TEXAS COMMISSION ON ENVIRONMENTAL QUALITY OSSF REGULATIONS AND THE ORDERS OF COMAL COUNTY AND WILL NOT CAUSE A NUISANCE OR HEALTH HAZARD
- ALL SPRINKLERS ARE HUNTER PGP-ARV-LA OR
- ANY CROSSING OF WATER LINE & SPRAY LINE WILL BE SLEEVED 10 ft ON EACH SIDE OF WATER LINE OR A BACK-FLOW PREVENTION DEVICE WILL BE INSTALLED
- NO PHYSICAL DRAINAGE FEATURE ON PROPERTY WHICH WOULD REQUIRE SPECIAL PROTECTIVE
- NO TEST HOLES DUG DUE TO EXTENSIVE SURFACE

DRAWING NO.:

7134R0


DATE: 27 JUN 2019

SCALE: 1'' = 40'

RECEIVED

JUL 18 2019



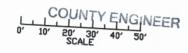





1'' = 40'

FILED BY ATC SPRING BRANCH F# 4000131700 931-VJB

Notice of confidentiality rights: If you are a natural person, you may remove or strike any or all of the following information from any instrument that transfers an interest in real property before it is filed for record in the public records: your Social Security number or your driver's license number.

### General Warranty Deed with Vendor's Lien

THE STATE OF TEXAS \$ KNOW ALL MEN BY THESE PRESENTS: \$

Executed on date of acknowledgement to be Effective on: January 29, 2018

Grantor: WILLIAM N. SCARBOROUGH, joined herein by his spouse Melissa Scarborough, Pro Forma

Grantor's Mailing Address: 24607 Kemper Eaks
San Antonio, Tuyan 78260

Grantee: KYLE CRAIG HERRING and ANDREA JOYCE HERRING

Grantee's Mailing Address: 431 Upland Ct., Canyon Lake, Comal County, Texas 78133-6084

Consideration: A note of even date executed by Grantee and payable to the order of ORIGIN BANK, Memorial City Financial Center, 9805 Katy Freeway, Ste. 200, Houston, Texas 77024, in the principal amount of FORTY-THREE THOUSAND ONE HUNDRED TWENTY-FIVE AND NO/100 DOLLARS (\$43,125.00). The note is secured by a first and superior vendor's lien and superior title retained in this deed in favor of ORIGIN BANK and by a first-lien deed of trust of even date from Grantee to TERRI GOLDEN CHASE, Trustee.

ORIGIN BANK, at Grantee's request, has paid in cash to Grantor that portion of the purchase price of the Property that is evidenced by the note. The first and superior vendor's lien against and superior title to the Property are retained for the benefit of ORIGIN BANK and are transferred to ORIGIN BANK without recourse against Grantor.

Property (including any improvements): Lot 447, Mountain Springs Ranch, Unit Three, situated in Comal County, Texas, according to plat thereof recorded in Volume 15, Pages 335-347, Map and Plat Records of Comal County, Texas.

Reservations from Conveyance: None.

Exceptions to Conveyance and Warranty: All presently recorded restrictions, reservations, easements, covenants and conditions that affect the property and taxes for the current year, the payment of which Grantee assumes.

Grantor, for the Consideration and subject to the Reservations from Conveyance and the Exceptions to Conveyance and Warranty, grants, sells, and conveys to Grantee the Property, together with all and singular the rights and appurtenances thereto in any way belonging, to have and to hold it to Grantee and Grantee's heirs, successors, and assigns forever. Grantor binds Grantor and Grantor's heirs and successors to warrant and forever defend all and singular the Property to Grantee and Grantee's heirs, successors, and assigns against every person whomsoever lawfully claiming or to claim the same or any part thereof, except as to the Reservations from Conveyance and the Exceptions to Conveyance and Warranty.

The vendor's lien against and superior title to the Property are retained until each note described is fully paid according to its terms, at which time this deed will become absolute.


When the context requires, singular nouns and pronouns include the plural.

WILLIAM N. SCARBOROUGH

ATTERNET IN FACT

THE STATE OF TEXAS COUNTY OF Comal

This instrument was acknowledged before me on this the 29th day of Jan. ,2018, by WILLIAMS N. SCARBOROUGH. individually and as Attorney-in-fact for Melissa Scarborough

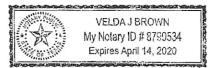

NOTARY PUBLIC, STATE OF TEXAS
Notary's Name Printed:
My Commission Expires:

AFTER RECORDING RETURN TO: Alamo Title Company GF No. 4000131700931 PREPARED IN THE LAW OFFICE OF: Kristen Quinney Porter, LLC P.O. Box 312643 New Braunfels, Texas 78131-2643

Filed and Recorded Official Public Records Bobbie Koepp, County Clerk Comal County, Texas 02/01/2018 08:21:07 AM TERRI 2 Pages(s) 201806003955

